

# PROPOSED SITE PLAN

**BULK TABLE** TAX MAP NO. 60.13-3-14 OWNER OF RECORD VALLEX HERARD PROPERTY ADDRESS 514 N BROADWAY **USE GROUP** R-3 SINGLE FAMILY DETACHED REQUIRED PROPOSED NET CHANGE NO CHANGE MIN. LOT AREA SF 20,000 SF 21,780 SF 21,780 SF 145.20' 145.20' NO CHANGE MIN. LOT WIDTH 100 FT MIN. FRONTAGE (FT) 145.20' 145.20' NO CHANGE MIN. FRONT YARD (FT) 35 FT 38.75' -3.75' MIN. SIDE YARD (EACH/TOTAL)(FT) 25 FT/ 50 FT 43 FT/ 28.33 FT - 25.57 FT TOTAL 96.9F7 TOTAL 71.33 FT MIN. REAR YARD SETBACK FT 69.92 FT 69.92 FT NO CHANGE 22'-4" MAX. BUILDING HT FT 22'-4" NO CHANGE MAX. BUILDING HT. (FT) ACCESSORY 15 FT N/A 36% 22% -14% MAX. DEVELOPMENT COVERAGE % 25% MAX BLDG COVERAGE % +3% 12% 7% 0.13 0.16 0.03 10 FT N/A MIN DISTANCE BETWEEN BLDGS ON SAME LOT MIN. SETBACK PARKING, DRIVEWAY, 5 FT 0.75 FT 12 FT +11.25 FT WALKWAY FROM ANY LOT LINE NO CHANGE MIN PARKING REQUIREMENTS

6 FT MAX.

**ELEVATION** 

SILT FENCE DETAIL

CENTER TO CENTER

36 IN MIN. FENCE POST

DRIVEN MIN. 16 IN INTO

GEOTEXTILE

L8 IN MIN. DEPTH

INTO GROUND

LENGTH

-GROUND

1,408

LIST OF DRAWINGS

SP-2 SITE DETAILS

**VICINITY MAP** 

**SQUARE FOOTAGE** 

1ST FLOOR

2ND FLOOR

TOTAL

**EXISTING LOT COVERAGE:** 1,450 DWELLING **EXISTING DRIVEWAY** 2,459 WALKWAY FRONT STOOP PATIO 803 POOL & PATIO 2,395 TOTAL EXISTING COVERAGE 7,292 PROPOSED LOT COVERAGE: 1,450 DWELLING **NEW GARAGE NEW WALKWAY** NEW VESTIBULE, STOOP/STEPS 130 PATIO CONC. STRIP/ PAD NEW POOL PATIO STEPS POOL & PATIO 2,395 (TOTAL PROPOSED COVERAGE\ <u>4,755</u> SFT THE EXISTING ASPHALT DRIVEWAY AND CONCRETE / ASPHALT PATIO WILL GET REPLACED WITH PERVIOUS PAVEMENT

RESULTING IN A LOT COVERAGE

WATER RETENTION IS REQUIRED.

REDUCTION OF 2,537 SFT. NO STORM

SURVEY

NOTE: CONSTRUCT SILT FENCE AROUND AREA TO BE DISTURBED DURING CONSTRUCTION, INCLUDING TEMPORARY SOIL STOCKPILE AREA. COMPLETELY & SEPARATELY ENCLOSE TEMPORARY SOIL STOCKPILE 36" MIN. FENCE POST LENGTH — FENCE POST 18" MIN. WOVEN SLIT FILM -ABOVE GROUND GEOTEXTILE 16 IN MIN. HEIGHT OF SLOPE - UNDISTURBED WOVEN SLIT FILM GROUND EMBED GEOTEXTILE -FENCE POST DRIVEN MIN. OF 8" VERTICALLY INTO A MIN. OF 16" INTO THE GROUND. BACKFILL AND THE GROUND COMPACT THE SOIL ON BOTH SIDES OF GEOTEXTILE.

ALL UTILITIES ARE SHOWN IN AN APPROXIMATE WAY FROM AVAILABLE INFORMATION. THE CONTRACTOR SHALL CALL THE LOCAL UNDERGROUND FACILITIES PROTECTIVE ORGANIZATION TO HAVE ALL UNDERGROUND UTILITIES MARKED IN THE FIELD PRIOR TO ANY CLEARING OR ANY CONSTRUCTION. THE CONTRACTOR SHALL ALSO VERIFY THE LOCATION, SIZE AND INVERT OF ALL UTILITIES PRIOR TO ANY CONSTRUCTION. ANY UTILITY FOR WHICH NO EVIDENCE CAN BE SEEN ON THE SURFACE OF THE LANDS MAY NOT BE SHOWN ON THIS DRAWING.

16 NYCRR PART 753 - PROTECTION OF UNDERGROUND FACILITIES REQUIRE 2 TO 10 WORKING DAYS NOTICE PRIOR TO START OF ANY UNDERGROUND WORK

#### **POOL FENCING NOTES**

POOL FENCING BARRIER SHALL BE IN ACCORDANCE WITH THE 2020 RCNYS SECTION R326. PER R326.4.2 PERMANENT BARRIERS HEIGHT SHALL BE NO LESS THAN 48" AT THE TOP AND NO MORE THAN 2" AT THE BOTTOM. MAXIMUM SPACING OF VERTICAL MEMBERS IS NOT TO EXCEED 4" CLEAR. WHERE THE BARRIER IS COMPOSED OF HORIZONTAL AND VERTICAL MEMBERS AND THE DISTANCE BETWEEN THE TOPS OF THE HORIZONTAL MEMBERS IS LESS THAN 45 INCHES, THE HORIZONTAL MEMBERS SHALL BE LOCATED ON THE SWIMMING POOL SIDE OF THE FENCE. SPACING BETWEEN VERTICAL MEMBERS SHALL NOT EXCEED 1 3 INCHES IN WIDTH. GATES MUST BE SELF CLOSING, SELF LATCHING, AND LOCKING. ALL GATES SHALL OPEN OUTWARD. LATCH HANDLE TO BE 40" ABOVE GRADE AND LOCATED WITHIN THE ENCLOSURE. IF LATCH HANDLE IS LESS THAN 54 INCHES FROM GRADE, LATCH HANDLE SHALL BE AT LEAST 3 INCHES BELOW TOP OF THE GATE, AND THERE SHALL BE NO OPENING GREATER THAN 0.5 INCH WITHIN 18 INCHES OF THE LATCH HANDLE. ALL GATES SHALL BE SECURELY LOCKED WITH A KEY, COMBINATION OR OTHER

CHILD-PROOF LOCK SUFFICIENT TO PREVENT ACCESS TO THE SWIMMING POOL THROUGH SUCH GATE WHEN THE SWIMMING POOL IS NOT IN USE OR SUPERVISED.

WHEN THE DWELLING IS A PART OF THE BARRIER ANY DOOR WITHIN THE ENCLOSURE MUST BE EQUIPPED WITH AN ALARM PER SECTION R326.4.2.8. OPERABLE WINDOWS IN THE WALL OR WALLS USED AS A BARRIER SHALL HAVE A LATCHING DEVICE LOCATED NO LESS THAN 48" ABOVE THE FLOOR. OPENINGS IN OPERABLE WINDOWS SHALL NOT ALLOW A 4- INCH-DIAMETER SPHERE TO PASS THROUGH THE OPENING WHEN THE WINDOW IS IN ITS LARGEST OPENED POSITION.

ENTRAPMENT PROTECTION: POOL SUCTION OUTLETS MUST COMPLY WITH SECTION R326.6. ALARMS MUST COMPLY WITH R326.7

SITE PLAN NOTES

1. PROPERTY REFERENCE: TAX MAP SECTION 60.13, BLOCK 3, LOT 14 AS SHOWN ON THE TAX MAP OF

THE VILLAGE OF UPPER NYACK 2. OWNER: VALLEX HERARD, 514 N. BROADWAY, UPPER NYACK NY 10960

3. SURVEY METES AND BOUNDS TAKEN FROM SURVEY BY EDWARD T. GANNON, DATED MAY 13, 2021.

ZONING: R-20

SCHOOL: NYACK UNIFIED SCHOOL DISTRICT FIRE: NYACK

WATER: UPPER NYACK LIGHTING:

SEWER: 5. THIS PLAN DOES NOT CONFLICT WITH THE COUNTY OFFICIAL MAP AND DOES NOT REQUIRE

APPROVAL SPECIFIED BY SECTION 239 OF THE NEW YORK GENERAL MUNICIPAL LAW. 6. ALL NEW UTILITY SERVICES SHALL BE INSTALLED UNDERGROUND.

7. IRON PINS, ¾" IN DIAMETER AND MINIMUM 30" LONG, SHALL BE INSTALLED AT ALL LOT CORNERS AFTER FINAL GRADING.

8. PLAN IS SUBJECT TO ALL STATE, COUNTY AND LOCAL CONSTRUCTION AND UTILITY STANDARDS AS APPLICABLE.

9. THE BUILDER SHALL COMPLY WITH THE APPROVED EROSION AND SEDIMENT CONTROL PLAN AND

THE "NEW YORK STATE STANDARDS FOR URBAN EROSION AND SEDIMENT CONTROL". 10. RETAINING WALLS SHALL BE DESIGNED BY AN ENGINEER LICENSED IN THE STATE OF NY AND DESIGN SHALL BE SUBMITTED FOR REVIEW WITH THE APPLICATION FOR BUILDING PERMIT. CERTIFICATION OF CONSTRUCTION IN ACCORDANCE WITH THE DESIGN, BY A NYS LICENSED PROFESSIONAL ENGINEER, SHALL BE SUBMITTED PRIOR TO APPLICATION FOR CERTIFICATE OF

OCCUPANCY. 11. SITE PLAN APPROVAL FOR THIS APPLICATION WAS GRANTED BY RESOLUTION OF THE VILLAGE OF UPPER NYACK PLANNING BOARD DATED . ONCE THIS SITE PLAN IS SIGNED BY THE PLANNING

BOARD CHAIR, IT SHALL EXPIRE IF:

A. A BUILDING PERMIT HAS NOT BEEN ISSUED FOR CONSTRUCTION IN ACCORDANCE WITH AN APPROVED SITE PLAN WITHIN 18 MONTHS OF THE DATE THAT THE SITE PLAN WAS SIGNED BY THE PLANNING BOARD CHAIR OR IF ALL IMPROVEMENTS PERMITTED OR REQUIRED BY THE SITE PLAN APPROVAL ARE NOT COMPLETED AND A CERTIFICATE OF OCCUPANCY AND/OR CERTIFICATE OF COMPLIANCE HAS NOT BEEN ISSUED WITHIN 2 YEARS OF THE DATE THAT THE BUILDING PERMIT IS ISSUED, UNLESS EXTENDED PURSUANT TO VILLAGE OF UPPER NYACK ZONING LAW (LOCAL LAW #5 OF 2022 AS AMENDED), §10.4.1.2. 12. THIS SITE PLAN IS SUBJECT TO COMPLIANCE WITH ALL LAWS, REGULATIONS, ORDINANCES AND

SPECIFICATIONS OF THE VILLAGE OF UPPER NYACK.

13. NO OUTDOOR LIGHTING SHALL PRODUCE ILLUMINATION BEYOND THE BOUNDARIES OF THE LOT ON WHICH IT IS LOCATED, AND LIGHT SOURCES SHALL BE SHIELDED FROM ADJACENT PROPERTIES. 14. ANY CHANGES OR MODIFICATIONS TO THIS SITE PLAN REQUIRE AMENDED SITE PLAN APPROVAL

FROM THE VILLAGE OF UPPER NYACK PLANNING BOARD. 15. THE CONTINUED VALIDITY OF ANY CERTIFICATE OF OCCUPANCY OR CERTIFICATE OF COMPLIANCE FOR THE IMPROVEMENTS DEPICTED ON THIS PLAN SHALL BE SUBJECT TO CONTINUED CONFORMANCE WITH THIS SITE PLAN AND THE CONDITIONS HERETO

16. ALL EXCAVATED MATERIAL SHALL BE REMOVED FROM THE SITE. 17. THE PLANS AND SPECIFICATIONS DEPICTED ON THESE DRAWINGS ARE IN COMPLIANCE WITH THE APPLICABLE PROVISIONS OF THE NEW YORK STATE UNIFORM FIRE PREVENTION AND BUILDING CODE AND THE NEW YORK STATE ENERGY CONSERVATION CONSTRUCTION CODE, AS CURRENTLY IN EFFECT.

HERARD RESIDENCE INTERIOR & EXTERIOR **RENOVATIONS & ADDITIONS** 

#### **VALLEX HERARD**

514 N BROADWAY UPPER NYACK, NY 10960

### MAREN ROBERTSON

ARCHITECTURE

MAREN ROBERTSON ARCHITECT

58 Washington Street Nyack, NY 10960 Tel: 845-553-5525 marencr@yahoo.com

REVISIONS

PLANNING BOARD SUBMISSION


DRAWING TITLE SITE PLAN **BULK TABLE** 

PROJECT NO. DRAWN BY


APRIL 4, 2023

5/4/23


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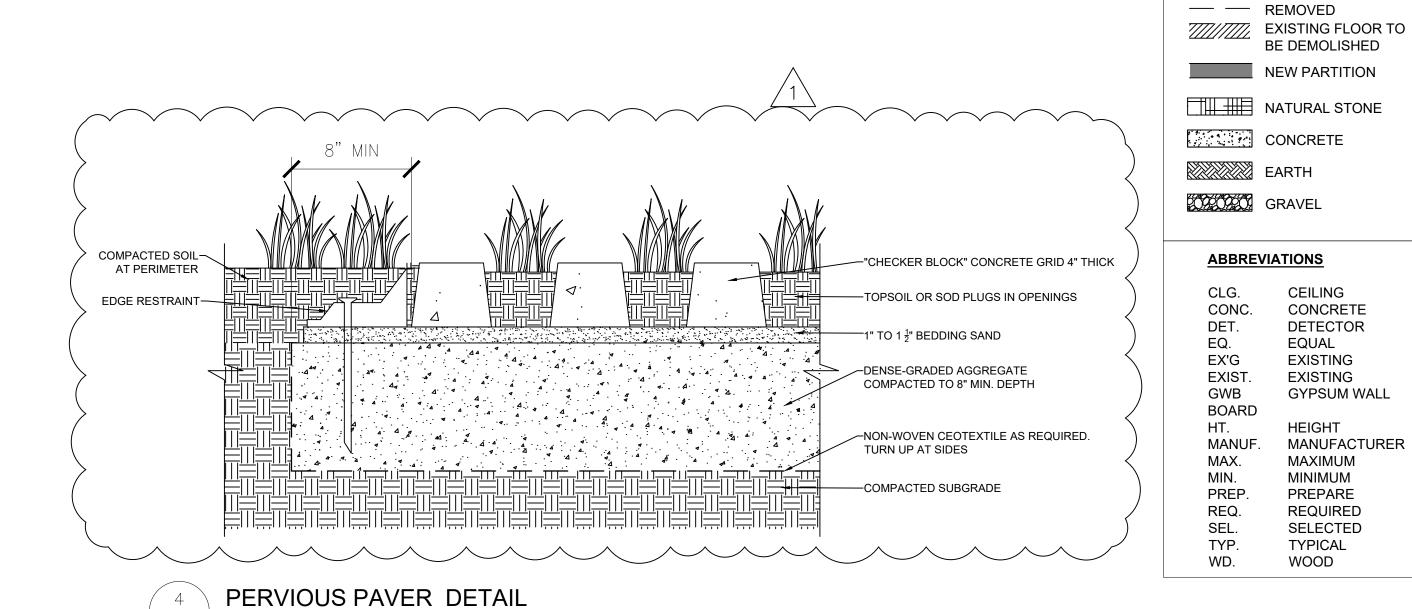
STEPS TO POOL PATIO

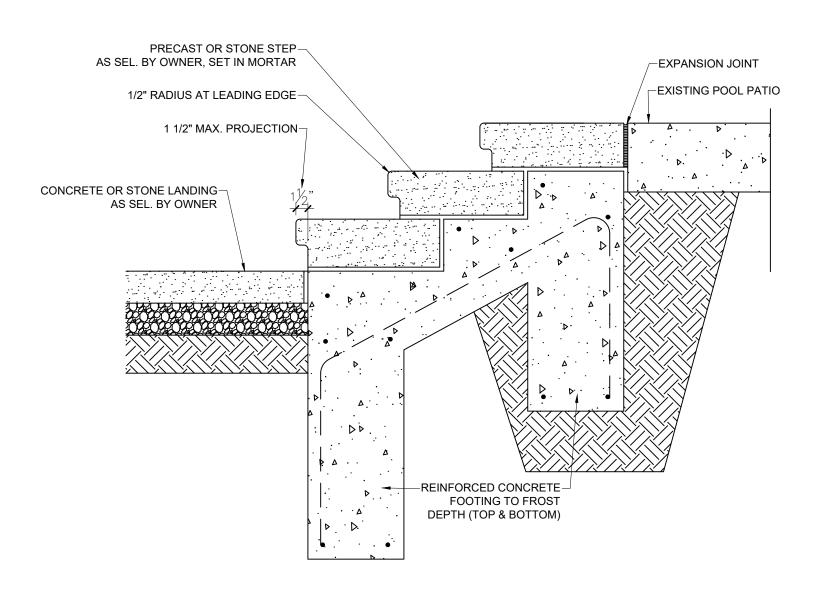

NEW 6' VINYL FENCE (4' FENCE SIMILAR) SP-2 / 1/2" = 1'-0"

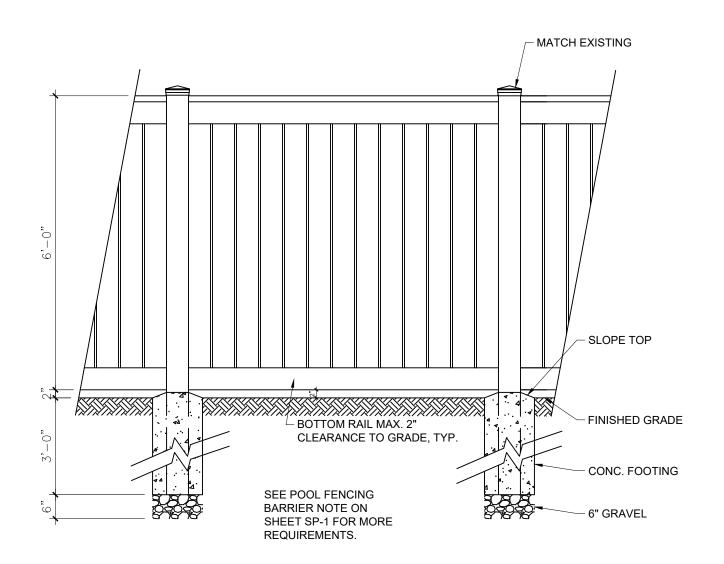

RETAINING WALL (NEW OR REPLACEMENT) SP-2 1" = 1'-0"

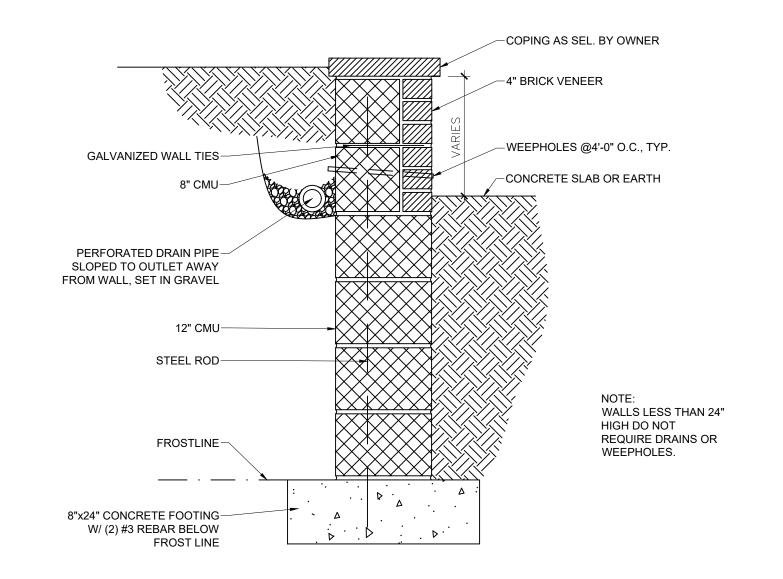

**GENERAL NOTES** 

 DO NOT SCALE THE DRAWINGS. USE DIMENSIONS INDICATED ONLY.

**CONSTRUCTION & DEMOLITION LEGEND** 

BE DEMOLISHED

CEILING

**EQUAL** 

**EXISTING** 

**EXISTING** 

HEIGHT

MAXIMUM

PREPARE

REQUIRED

SELECTED

**TYPICAL** 

WOOD

MINIMUM

**GYPSUM WALL** 

MANUFACTURER

CONCRETE

DETECTOR

EXISTING TO REMAIN

— — EXISTING TO BE

- 2. ALL WORK SHALL CONFORM TO LOCAL AND NEW YORK STATE CODE REQUIREMENTS. WORK SHALL NOT COMMENCE UNTIL A BUILDING PERMIT HAS BEEN ISSUED BY THE LOCAL BUILDING DEPARTMENT.
- 3. CONTRACTOR SHALL VERIFY ALL EXISTING CONDITIONS IN FIELD. CONTRACTOR TO NOTIFY OWNER/ARCHITECT OF ANY DISCREPANCY PRIOR TO CONSTRUCTION OR IMMEDIATELY UPON DISCOVERY.
- 4. ALL WOOD IN CONTACT WITH CONCRETE, MASONRY AND/OR SOIL SHALL BE PRESSURE-PRESERVATIVE-TREATED.

HERARD RESIDENCE INTERIOR & EXTERIOR RENOVATIONS & **ADDITIONS** 

**VALLEX HERARD** 

514 N BROADWAY UPPER NYACK, NY 10960

MAREN ROBERTSON ARCHITECTURE

MAREN ROBERTSON ARCHITECT

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REVISIONS

PLANNING BOARD SUBMISSION 4/4/23

**DRAWING TITLE** SITE DETAILS

PROJECT NO. 2334

DRAWN BY

SCALE AS NOTED

APRIL 4, 2023

5/4/23

## Checker Block®

Gives you the strength of concrete with steel reinforcement in areas where you wish to maintain a grassy look including overflow parking, service roads, tree pits and fire lanes. It is also ideal for stabilizing embankments along streams, rivers and lakes.




**Environmental Pavers** 





## Checker Block®

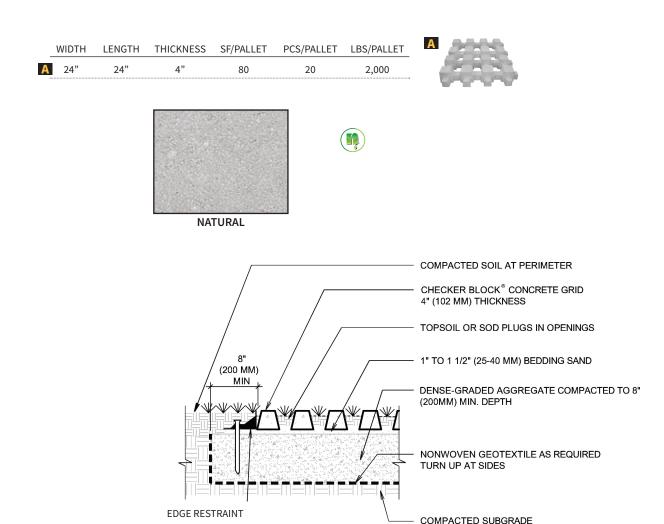

#### **INSTALLATION GUIDELINES: SAND**

After excavation, compact the subgrade and install a woven separation fabric. Spread and compact a base of clean, graded, dense aggregate (road base). Typical compacted base thickness is 4-6" for pedestrian applications. Pavers are set on a loosely screened 1" bed of graded, clean concrete sand. Maintain a joint size of 1/16" – 3/16". When pavers are set, compact paving stones into sand with mechanical plate vibrator. Joint sand may be spread over paving stones during compaction. Installed pavers should be set 1/8" to 1/4" above final elevations to compensate for any potential settlement. Spread clean dry sand over surface and broom sweep to fill joints.

**NOTE:** All measurements are nominal. Variance in square footage or linear footage coverage can be up to 5% depending on joint width. The possible occurrence of efflorescence does not affect the structural integrity of the product. Efflorescence is a normal occurrence in concrete products and will dissipate with normal weathering. The use of concrete as a base or setting bed may increase the possibility of efflorescence.

CAUTION: Always use a plate compactor with a pad when installing any textured paving stone.



